

TOMBALL ISD

TOMBALL WEST ELEMENTARY SCHOOL

JUERGEN ROAD
TOMBALL, TX

ISSUE FOR PROPOSAL
02/27/2023



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DRAWING INDEX

GENERAL	
G-000	COVER SHEET
G-001	SHEET INDEX
G-002	GENERAL PROJECT INFORMATION
G-010	1ST LEVEL - LIFE SAFETY EGRESS PLAN
G-020	ACCESSIBILITY GUIDELINES
G-030	FIRE RATED ASSEMBLIES
G-041	1ST FLOOR GRAPHICS & SIGNAGE PLAN - COMPOSITE
G-042	2ND FLOOR GRAPHICS & SIGNAGE PLAN - COMPOSITE
G-051	SIGNAGE GRAPHIC STANDARDS
G-052	SIGNAGE GRAPHIC STANDARDS

CIVIL	
C-001	NOTES, INDEX, AND LEGEND
C-002A	SURVEY (FOR INFORMATION ONLY)
C-002B	SURVEY (FOR INFORMATION ONLY)
C-002C	SURVEY (FOR INFORMATION ONLY)
C-002D	SURVEY (FOR INFORMATION ONLY)
C-003	DEMOLITION PLAN
C-101	SITE PLAN
C-102	DIMENSIONAL CONTROL PLAN
C-103	FIRE APPARATUS SAFETY PLAN
C-201	UTILITY PLAN
C-202	DRAINAGE PLAN
C-203	DRAINAGE AREA MAP
C-204	DRAINAGE CALCULATIONS
C-301	PAVING PLAN
C-302	GRADING PLAN
C-401	EROSION CONTROL PLAN
C-501	DETAILS
C-502	DETAILS
C-503	DETAILS

LANDSCAPE	
L-101	LANDSCAPE LAYOUT
L-102	LANDSCAPE LAYOUT
L-201	IRRIGATION LAYOUT
L-202	IRRIGATION LAYOUT

STRUCTURAL	
S-000	3D VIEW & SHEET INDEX
S-001	GENERAL NOTES
S-011	GENERAL NOTES
S-012	GENERAL SUBGRADE NOTES AND TYP DETAILS
S-101	COMPOSITE FOUNDATION PLAN
S-102	FOUNDATION PLAN - AREA A
S-101B	FOUNDATION PLAN - AREA B
S-101C	FOUNDATION PLAN - AREA C
S-101D	FOUNDATION PLAN - AREA D
S-101E	FOUNDATION PLAN - AREA E
S-101F	FOUNDATION PLAN - AREA F
S-101G	FOUNDATION PLAN - AREA G
S-101H	FOUNDATION PLAN - AREA H
S-102	COMPOSITE LOW ROOF FRAMING PLAN
S-102A	MEZZANINE/ LOW ROOF FRAMING PLAN - AREA A
S-102B	LOW ROOF FRAMING PLAN - AREA B
S-102C	LOW ROOF FRAMING PLAN - AREA C
S-102D	LOW ROOF FRAMING PLAN - AREA D
S-102E	MEZZANINE/ LOW ROOF FRAMING PLAN - AREA E
S-102F	LOW ROOF FRAMING PLAN - AREA F
S-102G	LOW ROOF FRAMING PLAN - AREA G
S-102H	LOW ROOF FRAMING PLAN - AREA H
S-103	COMPOSITE HIGH ROOF FRAMING PLAN
S-103A	HIGH ROOF FRAMING PLAN - AREA A
S-103B	HIGH ROOF FRAMING PLAN - AREA B
S-103C	HIGH ROOF FRAMING PLAN - AREA C
S-103E	HIGH ROOF FRAMING PLAN - AREA E
S-104	CLERESTORY ROOF AND MISC FRAMING PLANS
S-300	GENERAL CONCRETE AND STL REINF NOTES AND TYP DETAILS
S-301	GENERAL SLAB-ON-GRADE NOTES AND TYP DETAILS
S-302	GENERAL GRADE BEAM NOTES AND TYP DETAILS
S-303	GENERAL FOUNDATION NOTES AND TYP DETAILS
S-304	GENERAL FOUNDATION NOTES AND TYP DETAILS
S-310	FOUNDATION DETAILS
S-311	FOUNDATION DETAILS
S-312	FOUNDATION DETAILS (CMU)
S-313	FOUNDATION DETAILS (CMU)
S-320	SITE ITEMS FOUNDATION SECTIONS AND DETAILS
S-321	TYPICAL MARQUEE SIGN PLANS & DETAILS
S-400	GENERAL CMU NOTES AND TYP DETAILS
S-401	GENERAL CMU NOTES AND TYP DETAILS
S-402	MISC CMU DETAILS
S-403	MISC CMU DETAILS
S-600	GENERAL STEEL NOTES AND TYP DETAILS
S-601	GENERAL STEEL NOTES AND TYP DETAILS
S-602	GENERAL STEEL NOTES AND TYP DETAILS
S-603	GENERAL STEEL CONNECTION NOTES AND TYP DETAILS
S-604	GENERAL COMPOSITE STEEL NOTES AND TYP DETAILS
S-605	GENERAL COMPOSITE STEEL NOTES AND TYP DETAILS
S-606	GENERAL STEEL NOTES AND TYP DETAILS
S-607	GENERAL STEEL NOTES AND TYP DETAILS
S-608	GENERAL STEEL NOTES AND TYP DETAILS
S-610	COMPOSITE FRAMING DETAILS
S-620	ROOF FRAMING DETAILS
S-621	ROOF FRAMING DETAILS
S-622	ROOF FRAMING DETAILS
S-600	TYPICAL WIND BRACING ELEVATIONS
S-601	TYPICAL WIND BRACING ELEVATIONS
S-610	TYPICAL WIND BRACING DETAILS
S-700	TYPICAL LADDER DETAILS

ARCHITECTURAL	
A-001	ARCHITECTURAL SITE
A-0101	ARCHITECTURAL SITE PLAN
A-0102	ARCHITECTURAL ENLARGED SITE PLANS
A-0103	SITE DETAILS

ARCHITECTURAL	
A-101	1ST FLOOR PLAN - COMPOSITE
A-101A1	1ST FLOOR SCHEDULES - AREA A
A-101A	1ST FLOOR PLAN - AREA A
A-101B1	1ST FLOOR SCHEDULES - AREA B
A-101B	1ST FLOOR PLAN - AREA B
A-101C1	1ST FLOOR SCHEDULES - AREA C
A-101C	1ST FLOOR PLAN - AREA C
A-101D1	1ST FLOOR SCHEDULES - AREA D
A-101D	1ST FLOOR PLAN - AREA D
A-101E1	1ST FLOOR SCHEDULES - AREA E
A-101E	1ST FLOOR PLAN - AREA E
A-101F1	1ST FLOOR SCHEDULES - AREA F
A-101F	1ST FLOOR PLAN - AREA F
A-101G1	1ST FLOOR SCHEDULES - AREA G
A-101G	1ST FLOOR PLAN - AREA G
A-101H1	1ST FLOOR SCHEDULES - AREA H
A-101H	1ST FLOOR PLAN - AREA H
A-102	2ND FLOOR PLAN - COMPOSITE
A-102E1	2ND FLOOR SCHEDULES - AREA E
A-102E	2ND FLOOR PLAN - AREA E
A-201	1ST FLOOR CEILING PLAN - COMPOSITE
A-201A	1ST FLOOR CEILING PLAN - AREA A
A-201B	1ST FLOOR CEILING PLAN - AREA B
A-201C	1ST FLOOR CEILING PLAN - AREA C
A-201D	1ST FLOOR CEILING PLAN - AREA D
A-201E	1ST FLOOR CEILING PLAN - AREA E
A-201F	1ST FLOOR CEILING PLAN - AREA F
A-201G	1ST FLOOR CEILING PLAN - AREA G
A-201H	1ST FLOOR CEILING PLAN - AREA H
A-202	2ND FLOOR CEILING PLAN - COMPOSITE
A-202A	2ND FLOOR CEILING PLAN - AREA A
A-203	ENLARGED RCP & CEILING DETAILS
A-301	ROOF PLAN
A-302	ROOF PLAN - WIND ZONES
A-322	ROOF DETAILS (MOD BIT)
A-323	ROOF DETAILS (METAL)
A-324	BUILDING ENVELOPE DETAILS (NEW)
A-401	ENLARGED FLOOR PLANS
A-402	ENLARGED FLOOR PLANS
A-403	ENLARGED GYM STRIPING PLAN
A-404	ENLARGED STAIR RAMP PLANS & SECTION DETAILS
A-501	COMPOSITE EXTERIOR ELEVATIONS
A-502	ENLARGED EXTERIOR ELEVATIONS
A-503	INTERIOR ELEVATIONS
A-504	INTERIOR ELEVATIONS
A-505	INTERIOR ELEVATIONS
A-506	INTERIOR ELEVATIONS
A-601	BUILDING SECTIONS
A-602	BUILDING SECTIONS
A-603	BUILDING SECTIONS
A-604	BUILDING SECTIONS
A-605	WALL SECTIONS
A-606	WALL SECTIONS
A-607	WALL SECTIONS
A-608	WALL SECTIONS
A-609	WALL SECTIONS
A-701	EXTERIOR PLAN DETAILS
A-702	EXTERIOR PLAN DETAILS
A-703	EXTERIOR PLAN DETAILS
A-704	INTERIOR & EXTERIOR PLAN DETAILS
A-705	INTERIOR PLAN DETAILS
A-801A	PARTITION TYPES
A-801B	PARTITION TYPES
A-801C	PARTITION TYPES
A-811	DOOR, WINDOW, PANEL & FRAME TYPES
A-821	DOOR FRAME DETAILS
A-822	WINDOW FRAME DETAILS
A-840	CASEWORK ELEVATIONS
A-841	CASEWORK ELEVATIONS
A-842	CASEWORK ELEVATIONS
A-843	CASEWORK DETAILS

INTERIOR FINISHES	
AF-100	FINISH SCHEDULES
AF-101	1ST FLOOR FINISH PLAN - COMPOSITE
AF-101A	1ST FLOOR FINISH PLAN AREA "A"
AF-101B	1ST FLOOR FINISH PLAN AREA "B"
AF-101C	1ST FLOOR FINISH PLAN AREA "C"
AF-101D	1ST FLOOR FINISH PLAN AREA "D"
AF-101E	1ST FLOOR FINISH PLAN AREA "E"
AF-101F	1ST FLOOR FINISH PLAN AREA "F"
AF-101G	1ST FLOOR FINISH PLAN AREA "G"
AF-101H	1ST FLOOR FINISH PLAN AREA "H"


MECHANICAL	
M-101A	MECHANICAL FLOOR PLAN - FIRST FLOOR - AREA A
M-101B	MECHANICAL FLOOR PLAN - FIRST FLOOR - AREA B
M-101C	MECHANICAL FLOOR PLAN - FIRST FLOOR - AREA C
M-101D	MECHANICAL FLOOR PLAN - FIRST FLOOR - AREA D
M-101E	MECHANICAL FLOOR PLAN - FIRST FLOOR - AREA E
M-101F	MECHANICAL FLOOR PLAN - FIRST FLOOR - AREA F
M-101G	MECHANICAL FLOOR PLAN - FIRST FLOOR - AREA G
M-101H	MECHANICAL FLOOR PLAN - FIRST FLOOR - AREA H
M-102E	MECHANICAL FLOOR PLAN - SECOND FLOOR - AREA E
M-301	MECHANICAL ROOF PLAN
M-401	MECHANICAL CENTRAL PLAN PIPING DIAGRAMS
M-402	MECHANICAL CHILLED WATER PIPING DIAGRAMS
M-403	MECHANICAL HEATING WATER PIPING DIAGRAMS
M-404	MECHANICAL HEATING WATER PIPING DIAGRAMS
M-501	MECHANICAL SCHEDULES
M-502	MECHANICAL SCHEDULES
M-503	MECHANICAL SCHEDULES
M-601	MECHANICAL DETAILS
M-602	MECHANICAL DETAILS
M-603	MECHANICAL DETAILS
M-604	MECHANICAL DETAILS

ELECTRICAL	
ES-001	ELECTRICAL SITE PLAN NORTH
ES-002	ELECTRICAL SITE PLAN SOUTH
EP-101A	POWER PLAN - FIRST FLOOR - AREA A
EP-101B	POWER PLAN - FIRST FLOOR - AREA B
EP-101C	POWER PLAN - FIRST FLOOR - AREA C
EP-101D	POWER PLAN - FIRST FLOOR - AREA D
EP-101E	POWER PLAN - FIRST FLOOR - AREA E
EP-101F	POWER PLAN - FIRST FLOOR - AREA F
EP-101G	POWER PLAN - FIRST FLOOR - AREA G
EP-101H	POWER PLAN - FIRST FLOOR - AREA H
E-102A	ELECTRICAL FLOOR PLAN - SECOND FLOOR - AREA A - MEZZANINE
E-102E	ELECTRICAL FLOOR PLAN - SECOND FLOOR - AREA E - MEZZANINE
EL-201A	LIGHTING PLAN - FIRST FLOOR - AREA A
EL-201B	LIGHTING PLAN - FIRST FLOOR - AREA B
EL-201C	LIGHTING PLAN - FIRST FLOOR - AREA C
EL-201D	LIGHTING PLAN - FIRST FLOOR - AREA D
EL-201E	LIGHTING PLAN - FIRST FLOOR - AREA E
EL-201F	LIGHTING PLAN - FIRST FLOOR - AREA F
EL-201G	LIGHTING PLAN - FIRST FLOOR - AREA G
EL-201H	LIGHTING PLAN - FIRST FLOOR - AREA H
EL-202A	LIGHTING PLAN - SECOND FLOOR - AREA A - MEZZANINE
EL-202E	LIGHTING PLAN - SECOND FLOOR - AREA E - MEZZANINE
E-301	ELECTRICAL ROOF PLAN
E-401	ENLARGED ELECTRICAL PLANS - KITCHEN
E-501	ELECTRICAL ONE-LINE AND RISER DIAGRAMS
E-502	ELECTRICAL ONE-LINE AND RISER DIAGRAMS
E-503	ELECTRICAL ONE-LINE AND RISER DIAGRAMS
E-601	ELECTRICAL DETAILS AND FUTURE SCHEDULE
E-602	ELECTRICAL DETAILS, SYMBOL, LEGEND AND GENERAL NOTES
E-603	ELECTRICAL LIGHTING CONTROL DETAILS
E-604	ELECTRICAL LIGHTING CONTROL DETAILS
E-701	ELECTRICAL PANEL SCHEDULE
E-702	ELECTRICAL PANEL SCHEDULE
E-703	ELECTRICAL PANEL SCHEDULE
E-704	ELECTRICAL PANEL SCHEDULE
E-705	ELECTRICAL PANEL SCHEDULE

PLUMBING	
PS-101	PLUMBING SITE PLAN
PU-101A	PLUMBING UNDERFLOOR PLAN - AREA A
PU-101B	PLUMBING UNDERFLOOR PLAN - AREA B
PU-101C	PLUMBING UNDERFLOOR PLAN - AREA C
PU-101D	PLUMBING UNDERFLOOR PLAN - AREA D
PU-101E	PLUMBING UNDERFLOOR PLAN - AREA E
PU-101F	PLUMBING UNDERFLOOR PLAN - AREA F
PU-101G	PLUMBING UNDERFLOOR PLAN - AREA G
PU-101H	PLUMBING UNDERFLOOR PLAN - AREA H
P-101A	PLUMBING FLOOR PLAN - FIRST FLOOR - AREA A
P-101B	PLUMBING FLOOR PLAN - FIRST FLOOR - AREA B
P-101C	PLUMBING FLOOR PLAN - FIRST FLOOR - AREA C
P-101D	PLUMBING FLOOR PLAN - FIRST FLOOR - AREA D
P-101E	PLUMBING FLOOR PLAN - FIRST FLOOR - AREA E
P-101F	PLUMBING FLOOR PLAN - FIRST FLOOR - AREA F
P-101G	PLUMBING FLOOR PLAN - FIRST FLOOR - AREA G
P-101H	PLUMBING FLOOR PLAN - FIRST FLOOR - AREA H
P-103	PLUMBING FLOOR PLAN - SECOND FLOOR - AREA A - MEZZANINE
P-301	PLUMBING ROOF PLAN
P-401	PLUMBING ENLARGED PLAN
P-501	PLUMBING SCHEDULE
P-601	PLUMBING DETAILS
P-602	PLUMBING DETAILS
P-701	PLUMBING RISERS
P-702	PLUMBING RISERS

TECHNOLOGY	
T-000	TECHNOLOGY SYMBOLS AND LEGENDS
TS-101	TECHNOLOGY SITE PLAN
TF-101	FIRE ALARM OVERALL FIRST LEVEL FLOOR PLAN
TF-101A	FIRE ALARM FLOOR PLAN - FIRST FLOOR - AREA A
TF-101B	FIRE ALARM FLOOR PLAN - FIRST FLOOR - AREA B
TF-101C	FIRE ALARM FLOOR PLAN - FIRST FLOOR - AREA C
TF-101D	FIRE ALARM FLOOR PLAN - FIRST FLOOR - AREA D
TF-101E	FIRE ALARM FLOOR PLAN - FIRST FLOOR - AREA E
TF-101F	FIRE ALARM FLOOR PLAN - FIRST FLOOR - AREA F
TF-101G	FIRE ALARM FLOOR PLAN - FIRST FLOOR - AREA G
TF-101H	FIRE ALARM FLOOR PLAN - FIRST FLOOR - AREA H
TF-102E	FIRE ALARM FLOOR PLAN - SECOND FLOOR - AREA E - MEZZANINE
TN-101	TECHNOLOGY OVERALL FIRST LEVEL FLOOR PLAN
TN-101A	NETWORK FLOOR PLAN - FIRST FLOOR - AREA A
TN-101B	NETWORK FLOOR PLAN - FIRST FLOOR - AREA B
TN-101C	NETWORK FLOOR PLAN - FIRST FLOOR - AREA C
TN-101D	NETWORK FLOOR PLAN - FIRST FLOOR - AREA D
TN-101E	NETWORK FLOOR PLAN - FIRST FLOOR - AREA E
TN-101F	NETWORK FLOOR PLAN - FIRST FLOOR - AREA F
TN-101G	NETWORK FLOOR PLAN - FIRST FLOOR - AREA G
TN-101H	NETWORK FLOOR PLAN - FIRST FLOOR - AREA H
TN-102E	TECHNOLOGY FLOOR PLAN - AREA E - MEZZANINE
TN-201	ENLARGED MDF/IDF PLANS
TN-202	MDF/IDF RISER DIAGRAMS
TN-203	ENLARGED DIAGRAMS
TN-204	ENLARGED DIAGRAMS
TN-301	TECHNOLOGY MDF/IDF RISER DETAILS
TN-401	COLLABORATION AREAS TOPCAT SPEAKER SYSTEM DETAILS
TN-402	TOPCAT AND CAFETERIA SYSTEMS DETAILS
TN-403	GYMNASIUM LOCAL SOUND SYSTEM DETAILS

FOOD SERVICE	
K1	FS EQUIPMENT PLAN
K1.1	FS FACILITY MODEL
K1.2	FS EQUIPMENT MODEL
K1.3	FS SPECIAL CONDITIONS PLAN
K1.4	FS PLUMBING PLAN
K1.5	FS ELECTRICAL PLAN
K1.6	FS EXHAUST HOODS
K1.7	FS CONDENSING UNITS
K1.8	FS WALK-INS
K1.9	FS SERVING COUNTERS
K1.10	FS ELEVATIONS
K1.11	FS SECTIONS & DETAILS
K1.12	FS DETAILS

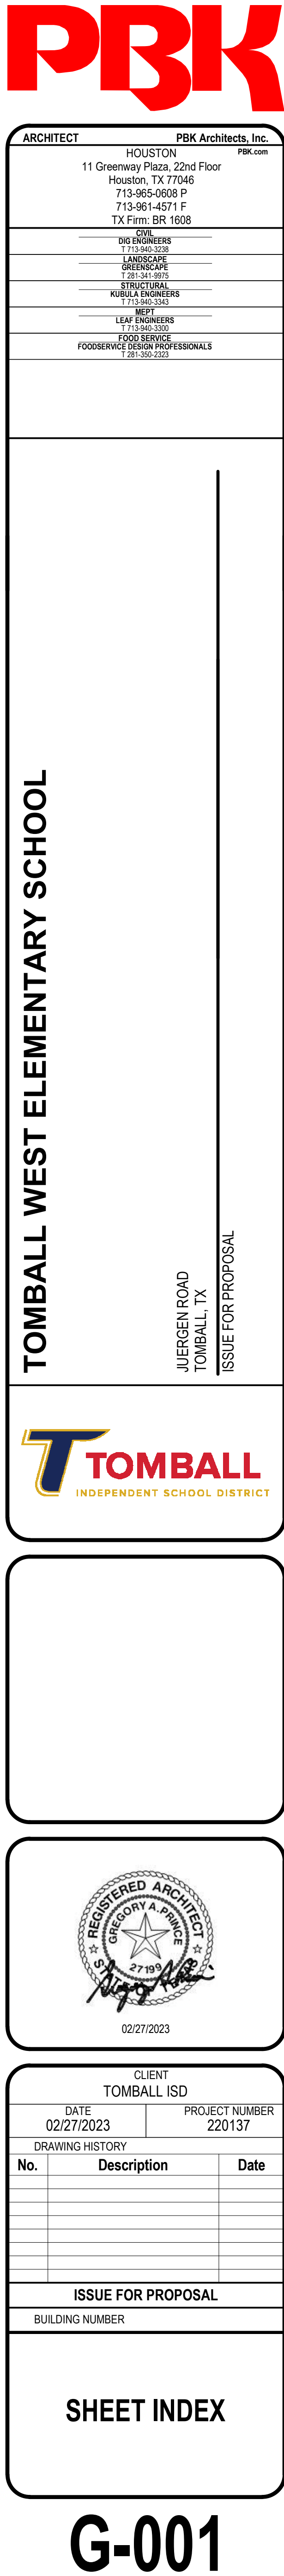

ABBREVIATIONS AND LEGEND KEYS

REFER TO SCHEDULES AND LEGENDS FOR ADDITIONAL ABBREVIATIONS
REFER TO OTHER DISCIPLINES FOR ADDITIONAL ABBREVIATIONS

A	above	EQUIP	equipment	MISC	miscellaneous	SYM	symmetrical
ABV	above	ETR	existing to remain	MO	masonry opening	T	tread
ACOUS	acoustical	EW	each way	MTD	mounted	T&G	trigauge & groove
ACT	acoustical ceiling tile	EXP. JT.	expansion joint	MTL	metal	TEL	telephone
AD	area drain	EXST	existing	N	north	TER	terrazzo
ADJ	adjustable	F	face	NIC	not in contact	THK	thick
AFF	above finished floor	F.A.	fire alarm	NO	number	THR	threshold
ALT	alternate	FAP	fire annunciator panel	NOM	nominal	TO	top of
ALUM	aluminum	FD	floor drain	NTS	not to scale	TYP	typical
APPROX	approximate	FE	fire extinguisher	O	overall	U	undercut
ARCH	architect	FEC	fire extinguisher cabinet	O.P.	overflow pipe	UC	unfinished
B	bottom of	FG	finish group	OA	on center	UNFN	unless noted otherwise
B.O.C.	bottom of	FH	fire hydrant	OC	outside diameter	UON	unless otherwise noted
BALC	balcony	FHC	fire hose cabinet	OFF	office	UTIL	utility
BD	board	FIN	finish	OH	opposite hand	V	vinyl composition tile
BET	between	FLR	floor	OPG	opening	VERT	vertical
BLDG	building	FUR	furnishing	QRP	opposite	VIF	very in field
BLUG	blocking	FLUOR	fluorescent	P	partition	VTR	vent termination pipe
BLW	below	FT	foot rest	PART	partition	VWC	vinyl wall covering
BM	beam	FUR	furnishing	PERM	permanent	W	west
BOT	bottom	G	gallon	PG	paint grade	W	with
BRKT	bracket	GAL	galvanized	PLAM	plastic laminate	WO	without
BULKHD	bulkhead	CALV	calvin	PLAS	plaster	WC	watercloset
BUR	built up roof	GC	general contractor	PLAS	plaster	WIN	window
C	corner	GL	glass	PLYWD	plywood	WP	waterproof
C.G.	corner guard	GND	ground	PR	pair	WS	wetstack
CAB	cabinet	GWB	gypsum board	PT	paint	WST	wetstack
CALK	caulking	GYP	gypsum	PTD	painted	WT	weight
CER	ceramic	H	hot water heater	R	riser		
CJ	control joint	H.W.H.	hot water heater	RAD	radius		
CLG	ceiling	HC	handcapped	RCP	reflected ceiling plan		
CLOS	closet	HDWD	hardwood	RD	roof drain		
CLR	clear	HDWR	hardware	RE	refer		
CO	cased opening	HM	hollow metal	REF	refrigerator		
COL	column	HORIZ	horizontal	REINF	reinforced		
CONC	concrete	HR	hour	REQD	required		
CONT	continuous	HT	height	RESIL	resilient		
CPT	carpet	I	inner diameter	RM	room		
CT	ceramic tile	ID	inner diameter	S	rough opening		
CTR	center	INCAN	insandescant	RO	rough top unit (mech)		
D	double	INSUL	insulation	RTU	rough top unit (mech)		
DET	detail	INT	interior	S	south		
DIA	diameter	J	janitor	SABF	sound attenuation fiber batt		
DM	dimension	JAN	janitor	SC	scoopir		
DN	down	JST	joint	SCHED	schedule		
DR	door	JT	joint	SEAL	sealant		
DS	down spout	L	laminate	SECT	section		
DW	dishwasher	LAM	laminate	SF	square foot		
DWG	drawing	LAV	lavatory	SHT	sheet		
E	east	LB(S)	pounds	SIM	similar		
EA	each	LDG	landing	SPEC	specification		
EFS	exterior insulation & finish system	LT	light	SQ	square		
ELEC	electrical	M	maximum	STD	standard		
ELEV	elevation	MAX	maximum	STL	steel		
EMER	emergency	MECH	mechanical	STOR	storage		
ENCL	enclosure	MEMB	membrane	STRUCT	structural		
EOS	edge of slab	MFR	manufacturer	SUSP	suspended		
EQ	equal	MIN	minimum				

GENERAL NOTES

- THE CONSTRUCTION DOCUMENTS ARE TO INCLUDE AIA DOCUMENT A201 "GENERAL CONDITIONS OF THE CONTRACT FOR CONSTRUCTION". CLIENT SHALL BE DESIGNATED AS "THE OWNER". PBK SHALL BE DESIGNATED AS "THE ARCHITECT". FACILITY SHALL BE DESIGNATED AS "THE LANDLORD". THE CONTRACT DOCUMENT SHALL ALSO INCLUDE THE AGREEMENT, PERFORMANCE AND PAYMENT BONDS, GENERAL CONDITIONS, SUPPLEMENTARY CONDITIONS, THE SPECIFICATIONS, THE DRAWINGS ADDENDUM, AND CONTRACT MODIFICATIONS, BUILDING RULES AND REGULATIONS & ANY OTHER DOCUMENTS REQUIRED BY THE OWNER.
- THE GENERAL CONTRACTOR SHALL BE BOTH LICENSED AND BONDED IN STATE OF PROJECT LOCATION AND SHALL PROVIDE DOCUMENTS UPON REQUEST.
- THE WORK SHALL BE DONE IN ACCORDANCE WITH THE RULES AND REGULATIONS OF ALL APPLICABLE SAFETY AND BUILDING CODES, AND AS APPROVED BY THE AUTHORITY HAVING JURISDICTION. THE GENERAL CONTRACTOR IS RESPONSIBLE FOR SECURING AND PAYING FOR ALL PERMITS REQUIRED FOR THE WORK AND FOR THE SCHEDULING OF ALL REQUIRED INSPECTIONS DURING THE COURSE OF THE WORK.
- THE GENERAL CONTRACTOR SHALL REVIEW AND VERIFY EXISTING CONDITIONS AS PROVIDED IN THE CONSTRUCTION DOCUMENTS. THE CONTRACTOR SHALL NOTIFY THE ARCHITECT OF ALL DISCREPANCIES, ERRORS, INCONSISTENCIES OR AMBIGUITIES PRIOR TO PROCEEDING WITH THE WORK.
- THE GENERAL CONTRACTOR SHALL BE RESPONSIBLE FOR, AND PROVIDE PROTECTION OF, ANY EXISTING FINISHES, MATERIALS, AND EQUIPMENT TO REMAIN. THE GENERAL CONTRACTOR SHALL REPAIR OR REPLACE ANY DAMAGED FINISHES, MATERIALS, AND EQUIPMENT AS A RESULT OF THE WORK. ALL EXISTING FINISHES TO REMAIN SHALL BE CLEANED AT THE COMPLETION OF CONSTRUCTION. THE GENERAL CONTRACTOR SHALL PHOTOGRAPH AND DOCUMENT ALL EXISTING DAMAGES, AND PROVIDE TO THE ARCHITECT, PRIOR TO PROCEEDING WITH THE WORK.
- ALL MATERIALS AND SYSTEMS SHALL BE INSTALLED PER MANUFACTURER'S SPECIFICATIONS. ALL CONSTRUCTION SHALL BE OF INDUSTRY STANDARD OR BETTER. THE ARCHITECT SHALL BE FINAL JUDGE OF QUALITY.
- ONLY NEW MATERIALS AND EQUIPMENT OF RECENT MANUFACTURE, OF STANDARD QUALITY AND FREE FROM DEFECTS, WILL BE PERMITTED IN THE WORK. UNLESS OTHERWISE NOTED, REJECTED MATERIALS AND EQUIPMENT SHALL BE REMOVED IMMEDIATELY FROM THE WORK AND REPLACED WITH MATERIALS AND EQUIPMENT OF THE QUALITY SPECIFIED. FAILURE TO REMOVE REJECTED MATERIALS AND EQUIPMENT SHALL NOT RELIEVE THE GENERAL CONTRACTOR FROM THE RESPONSIBILITY FOR QUALITY OF MATERIAL AND EQUIPMENT USED NOR FROM ANY OTHER OBLIGATION IMPOSED BY THE CONTRACT.
- IN THE EVENT OF CONFLICT BETWEEN DATA SHOWN ON DRAWINGS AND DATA PROVIDED IN THE SPECIFICATION, THE SPECIFICATION SHALL GOVERN. DETAIL DRAWINGS TAKE PRECEDENT OVER DRAWINGS OF LARGER SCOPE. THE CONTRACTOR SHALL PROVIDE WRITTEN NOTIFICATION TO THE ARCHITECT OF ANY DISCREPANCIES PRIOR TO PROCEEDING WITH THE WORK. IN CASE OF AN INCONSISTENCY BETWEEN DRAWINGS AND SPECIFICATIONS OR WITHIN EITHER DOCUMENT, NOT CLARIFIED BY ADDENDUM, THE MORE SPECIFIC PROVISION SHALL TAKE PRECEDENCE.
- DO NOT SCALE DRAWINGS. STATED & WRITTEN DIMENSIONS GOVERN. THE GENERAL CONTRACTOR SHALL VERIFY ALL DIMENSIONS IN THE FIELD AND SHALL BE RESPONSIBLE FOR THEIR ACCURACY. NO EXTRA CHARGE OR COMPENSATION SHALL BE ALLOWED BECAUSE OF DIFFERENCE BETWEEN ACTUAL DIMENSIONS AND THOSE INDICATED ON THE DRAWINGS, UNLESS THEY CONTRIBUTE TO A CHANGE IN THE SCOPE OF THE WORK. ANY DIFFERENCE FOUND SHALL BE SUBMITTED TO THE ARCHITECT FOR COORDINATION PRIOR TO ORDERING, MANUFACTURING, OR PROCEEDING WITH THE WORK. HORIZONTAL DIMENSIONS INDICATED ARE TOP/ROM FACE OF FINISH, UNLESS NOTED OTHERWISE. VERTICAL DIMENSIONS ARE FROM TOP OF FLOOR SLAB EXCEPT WHERE NOTED TO BE ABOVE FINISHED FLOOR (AFF). DIMENSIONS ARE NOT ADJUSTABLE WITHOUT APPROVAL OF ARCHITECT UNLESS NOTED "+/-".
- THE GENERAL CONTRACTOR SHALL VERIFY THAT NO CONFLICTS EXIST BETWEEN THE LOCATIONS OF EXISTING AND PROPOSED NEW MECHANICAL, ELECTRICAL, PLUMBING, DATA, AND SPRINKLER EQUIPMENT (INCLUDING BUT NOT LIMITED TO STRUCTURAL MEMBERS, PIPING, DUCT WORK, CONDUIT AND SPRINKLERS) AND THAT CLEARANCES FOR INSTALLATION AND MAINTENANCE OF EQUIPMENT ARE PROVIDED. ELEMENTS IN CONFLICT SHALL BE DOCUMENTED AND PROVIDED TO THE ARCHITECT PRIOR TO PROCEEDING WITH THE WORK.
- THE GENERAL CONTRACTOR SHALL PROVIDE THE ARCHITECT WITH SHOP DRAWINGS FOR REVIEW AND APPROVAL, FOR ALL, BUT NOT LIMITED TO, THE FOLLOWING: SHOP-FABRICATED MILLWORK, CARPET LAYOUT, FLOORING, LIGHT FIXTURES, DOORS, MISC. STEEL, METAL FABRICATION, GLASS/CLAZING, SPRINKLER LAYOUTS, HARDWARE. SHOP DRAWINGS SHALL BE SUBMITTED IN THE FORM OF 3 SETS OF PRINTS. SHOP DRAWINGS SHALL NOT BE REPRODUCTIONS OF CONTRACT DOCUMENTS. MATERIAL SUBMITTALS (3 SAMPLES) SHALL BE PROVIDED FOR WOOD, FASTENERS, ACRYLIC, CARPET, TILE, BASE, PAINT, LAMINATE AND ANY OTHER MATERIALS INDICATED IN THE SHOP DRAWING.
- THE GENERAL CONTRACTOR SHALL PROVIDE THE ARCHITECT WITH MANUFACTURERS CUT SHEETS AND SPECIFICATIONS FOR ALL EQUIPMENT INCLUDING BUT NOT LIMITED TO: LIGHT FIXTURES, PLUMBING EQUIPMENT, ELECTRICAL EQUIPMENT, FANS, SUPPLEMENTARY HEATING AND COOLING ELEMENTS, ALL HARDWARE AND SECURITY EQUIPMENT.
- THE GENERAL CONTRACTOR SHALL NOT PROCEED WITH WORK FOR WHICH HE EXPECTS ADDITIONAL COMPENSATION BEYOND THE CONTRACT AMOUNT WITHOUT WRITTEN AUTHORIZATION FROM THE ARCHITECT AND OWNER. FAILURE TO OBTAIN SUCH AUTHORIZATION SHALL INVALIDATE A CLAIM FOR EXTRA COMPENSATION. THE CONTRACTOR SHALL NOT PROCEED WITH WORK WHICH, IF COMPLETED IN STRICT CONFORMANCE WITH THE CONSTRUCTION DOCUMENTS, WILL RESULT IN ADDITIONAL WORK BEYOND THE SCOPE OF THE CONTRACT WITHOUT WRITTEN AUTHORIZATION FROM THE ARCHITECT AND OWNER. ANY FIELD CONDITIONS THAT SIGNIFICANTLY VARY FROM THE CONTRACT DOCUMENTS OR WILL RESULT IN ADDITIONAL WORK, SHALL BE BROUGHT TO THE ATTENTION OF THE ARCHITECT PRIOR TO PROCEEDING WITH WORK.
- THE GENERAL CONTRACTOR SHALL INCLUDE ALL X-RAY AND CORE DRILL COSTS. THE GENERAL CONTRACTOR SHALL REVIEW AND COORDINATE THE SIZE AND LOCATION OF ALL SLAB OPENINGS WITH ALL RELATED DISCIPLINES. THE GENERAL CONTRACTOR SHALL SUBMIT PROPOSED LOCATIONS OF CORE DRILLING AND SLAB OPENINGS TO ARCHITECT AND STRUCTURAL ENGINEER OF RECORD FOR REVIEW AND APPROVAL PRIOR TO PROCEEDING WITH THE WORK.
- PATCH, REPAIR, AND INSTALL ALL FIREPROOFING AS REQUIRED BY CODE. FIREPROOF ALL NEW PENETRATIONS AS REQUIRED FOR APPROVAL BY THE AUTHORITY HAVING JURISDICTION.
- WHERE BUILDING SEISMIC JOINTS ARE LOCATED, THE GENERAL CONTRACTOR SHALL PROVIDE APPLICABLE CODE AND INDUSTRY BEST PRACTICES FOR ROUTING OF ALL PIPING, DUCTS, CONDUITS AND OTHER CONTINUOUS RUNS.
- THE GENERAL CONTRACTOR SHALL CONTINUOUSLY CHECK ARCHITECTURAL AND STRUCTURAL CLEARANCES FOR ACCESSIBILITY OF EQUIPMENT AND MECHANICAL AND ELECTRICAL SYSTEMS. NO ALLOWANCES OF ANY KIND WILL BE MADE FOR THE GENERAL CONTRACTOR'S NEGLIGENCE TO FORESEE MEANS OF INSTALLING EQUIPMENT INTO POSITION.
- THE FINISHED WORK SHALL BE FIRM, WELL-ANCHORED, IN TRUE ALIGNMENT, PLUMB, LEVEL, WITH SMOOTH, CLEAN, UNIFORM, APPEARANCE WITHOUT WAVES, DISTORTIONS, HOLES, MARKS, CRACKS, STAINS, OR DISCOLORATION. JOINTING SHALL BE CLOSE FITTING, NEAT AND WELL SORBED. THE FINISHED WORK SHALL HAVE NO EXPOSED UNSIGHTLY ANCHORS OR FASTENERS AND SHALL NOT PRESENT HAZARDOUS, UNSAFE CORNERS. ALL WORK SHALL HAVE THE PROVISION FOR EXPANSION, CONTRACTION AND SHRINKAGE AS NECESSARY TO PREVENT CRACKS, BUCKLING, AND WARPING DUE TO TEMPERATURE AND HUMIDITY CONDITIONS.
- ATTACHMENTS, CONNECTIONS OR FASTENERS OF ANY NATURE ARE TO PROPERLY AND PERMANENTLY BE SECURED IN CONFORMANCE WITH INDUSTRY BEST PRACTICES. THE DRAWINGS HIGHLIGHT SPECIAL CONDITIONS ONLY AND BY NO MEANS ILLUSTRATE EVERY CONNECTION. THE CONTRACTOR IS RESPONSIBLE FOR IMPROVING CONNECTION ACCORDINGLY.
- GENERAL CONTRACTOR SHALL WAIVE "COMMON PRACTICE" AND "COMMON USAGE" AS CONSTRUCTION CRITERIA WHEREVER DETAILS AND CONTRACT DOCUMENTS OF GOVERNING CODES, ORDINANCES, ETC. REQUIRE QUANTITY OR BETTER QUALITY THAN COMMON PRACTICE OR COMMON USAGE WOULD REQUIRE.
- THE GENERAL CONTRACTOR SHALL SUBMIT SHOP DRAWINGS AND SUBMITTALS AND SHALL ORDER AND SCHEDULE DELIVERY OF MATERIALS TO AVOID DELAYS IN CONSTRUCTION. IF AN ITEM IS FOUND TO BE UNAVAILABLE OR TO HAVE A LONG LEAD TIME, THE GENERAL CONTRACTOR SHALL NOTIFY ARCHITECT IMMEDIATELY WITH A PROPOSED ALTERNATIVE.
- THE GENERAL CONTRACTOR SHALL NOTIFY THE OWNER, THE LANDLORD, AND THE ARCHITECT IN WRITING OF ANY DEFICIENCIES IN BASE BUILDING WORK PRIOR TO THE COMMENCEMENT OF THE WORK. ANY UNREPORTED DEFICIENCIES WILL BECOME THE RESPONSIBILITY OF THE GENERAL CONTRACTOR TO CORRECT.
- THE GENERAL CONTRACTOR SHALL EXERCISE INDUSTRY BEST PRACTICES FOR CARE AND CAUTION DURING THE CONSTRUCTION OF THE WORK, AND SHALL SCHEDULE WORK TO MINIMIZE DISTURBANCES TO OCCUPANTS, ADJACENT SPACES AND/OR STRUCTURES, PROPERTY, PUBLIC THOROUGHFARES, ETC. THE GENERAL CONTRACTOR SHALL TAKE PRECAUTIONS AND BE RESPONSIBLE FOR THE SAFETY OF ALL BUILDING OCCUPANTS DURING CONSTRUCTION PROCEDURES. THE GENERAL CONTRACTOR SHALL BE RESPONSIBLE FOR ANY COSTS INCURRED.
- ALL DEBRIS SHALL BE REMOVED FROM THE SITE ON A DAILY BASIS, OR AS DIRECTED BY THE AUTHORITY HAVING JURISDICTION. UPON COMPLETION OF THE WORK, REMOVE ALL DEBRIS FROM THE BUILDING CREATED BY THE WORK PROVIDED UNDER THIS CONTRACT AND LEAVE ALL AREAS CLEAN. TRASH IS NOT PERMITTED TO BE BURNED ON SITE.
- ALL ABANDONED AND MISCELLANEOUS NAILS, HANGERS, STAPLES, WIRES, CONDUITS AND DEBRIS SHALL BE REMOVED FROM EXPOSED AREAS OF THE FLOORS, WALLS, AND CEILINGS. REMOVE ALL ABANDONED PIPE SLEEVES IN FLOOR SLABS. PATCH EXISTING SLAB AS REQUIRED TO MAINTAIN UL FIRE RATING OF FLOOR SLAB WHERE PIPES AND CONDUITS HAVE BEEN REMOVED.
- SLAB PENETRATIONS SHALL BE SEALED AS REQUIRED TO MAINTAIN FIRE RATING, USING MATERIALS AND METHODS APPROVED BY THE AUTHORITY HAVING JURISDICTION. EXPANSION MATERIAL SHALL BE APPROVED BY THE ARCHITECT.
- THE GENERAL CONTRACTOR SHALL NOTIFY THE ARCHITECT OF ANY ACCESS PANELS WHICH MAY BE REQUIRED PRIOR TO PROCEEDING WITH THE WORK. CONTRACTOR SHALL BE RESPONSIBLE FOR COORDINATING ALL TRADES. REQUIRED ACCESS PANELS SHALL BE INCLUDED IN THE CONTRACTOR'S SCOPE OF WORK.
- CONTRACTOR SHALL PROVIDE THE TEAM WITH A CONSTRUCTION SCHEDULE SHOWING THE PROPOSED PHASING. LONG LEAD ITEMS THAT WILL AFFECT THE SUBSTANTIAL COMPLETION DATE SHALL BE BROUGHT TO THE ARCHITECT'S ATTENTION IMMEDIATELY.

PROJECT SUMMARY

THIS PROJECT CONSISTS OF A NEW 121,180 SF ELEMENTARY SCHOOL WITH ACADEMIC INSTRUCTION AREAS, A RESOURCE CENTER, ART AND FINE ARTS CLASSROOMS, GYMNASIUM, CAFETERIA WITH A PLATFORM, AND ADMINISTRATIVE OFFICES.

SITE IMPROVEMENTS INCLUDE FACULTY AND VISITOR PARKING AREAS TOTALING 186 SPACES; DROP-OFF AREAS FOR BUSES, AUTOMOBILES, SPECIAL EDUCATION, DAY-CARE VEHICLES AND PLAY AREAS.

PROJECT GRAPHIC REFERENCES

PROJECT SYMBOLS

PLAN NORTH
NORTH ARROW

TRUE NORTH
NORTH ARROW

WORKING POINT
LEVEL POINT
DATUM POINT
SPOT ELEVATION
TOP OF FRAMING/STEEL

FIRE RATING TYPE
CORE STRUCTURAL WIDTH TYPE
COMPOSITION TYPE
PARTITION TYPE TAG
(RE: PARTITION SCHEDULE)

BLDG AREA
LEVEL
DOOR SEQUENCE
(RE: DOOR SCHEDULE)

ROOM—ROOM NAME
(RE: ROOM FINISH SCHEDULE)
ROOM SEQUENCE
LEVEL
BLDG AREA

EXIT SIGN
DIRECTION SYMBOL

MATCHLINE
SEE 7/A701
VIEW REFERENCE

FF&E TAG

CURTAINWALL TAG
STOREFRONT TAG

KEYNOTE TAG

WINDOW & LOUVER TAG

MATERIAL TAG

REVISION TAG

FINISH MATERIAL
CASEWORK TYPE (AWI SERIES)
SIZE (WxH)

PROJECT SYMBOLS

ACT-1
8'-0"

CEILING TYPE
CEILING HEIGHT

COLUMN LINE
REFERENCE

EXISTING/NEW
COLUMN LINE
REFERENCE

DETAIL NUMBER
SHEET NUMBER
CALLOUT
REFERENCE
REFERENCE

EXTERIOR
REFERENCE
ELEVATION NUMBER
SHEET NUMBER

INTERIOR
REFERENCE
ELEVATION NUMBER
SHEET NUMBER

REFERENCE
BUILDING SECTION
REFERENCE
DETAIL NUMBER
SHEET NUMBER

REFERENCE
WALL SECTION
REFERENCE
DETAIL NUMBER
SHEET NUMBER

CENTER LINE, & SYMBOL

ABOVE LINE

BEYOND LINE

BREAK LINE

CONSTRUCTION TYPE SYMBOLS

EXISTING CONSTRUCTION TO REMAIN

EXISTING CONSTRUCTION TO BE DEMOLISHED

NEW NON-RATED CONSTRUCTION

MATERIAL INDICATIONS

CONCRETE

BRICK

CONC. MASONRY UNITS (CMU)

RIGID INSULATION

BATT INSULATION

ACOUSTICAL TILE / FABRIC PANEL

GYPSUM BOARD

PLASTER ON METAL LATH

FINISH WOOD

CONTINUOUS WOOD

BLOCKING / SHIM

PLYWOOD

EARTH

CAST STONE / SPRAY ON INSULATION / SAND / MORTAR

STEEL

ALUMINUM


STONE

GRAVEL

SEALANT

ROD STOCK & SEALANT

VICINITY MAP

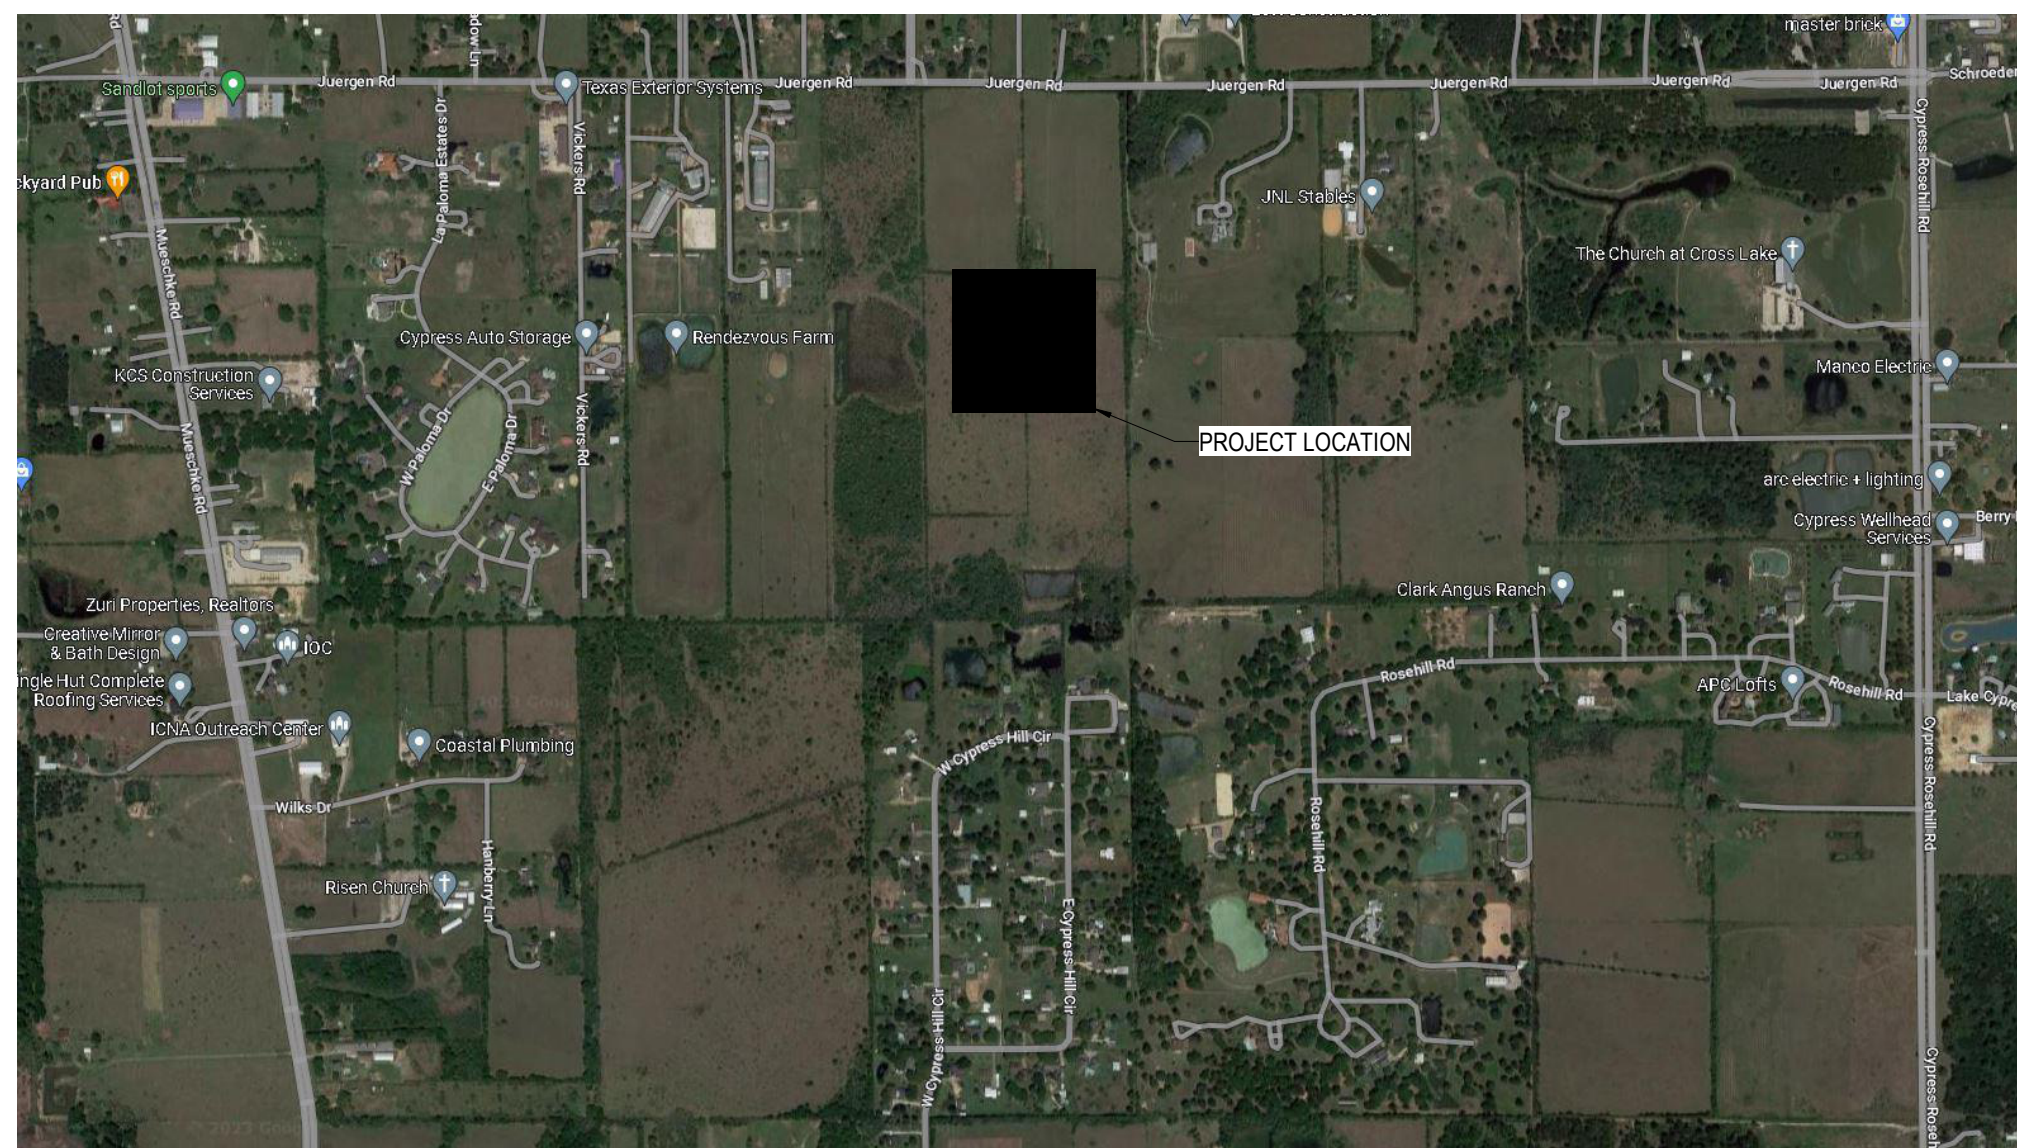

PROJECT GRAPHIC REFERENCES

SHEET NUMBER

A-201A1

FLIP SHEET (Schedules)
BUILDING AREA
LEVEL REFERENCE
SHEET SERIES TYPE

DISCIPLINE	SUBDISCIPLINE	0
G	GENERAL	1
C	CIVIL	2
CA	SPORTS CIVIL	3
SA	SPORTS ARCH	4
S	STRUCTURAL	5
L	LANDSCAPE	6
D	DEMOLITION	7
A	ARCHITECTURAL	8
M	MECHANICAL	9
E	ELECTRICAL	
P	PLUMBING	
T	TECHNOLOGY	
FS	FOOD SERVICE	
AV	ACOUSTICAL	
TH	THEATRICAL	



ARCHITECT **PBK Architects, Inc.**
HOUSTON
11 Greenway Plaza, 22nd Floor
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TX Firm BR 1658

DESIGNER
1713-965-1234
LANDSCAPE
1713-965-1234
STRUCTURAL
1713-965-1234
METAL FABRICATORS
1713-965-1234
MECHANICAL
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ELECTRICAL
1713-965-1234
FOOD SERVICE
FOOD SERVICE DESIGN PROFESSIONALS

LEAD ARCHITECT
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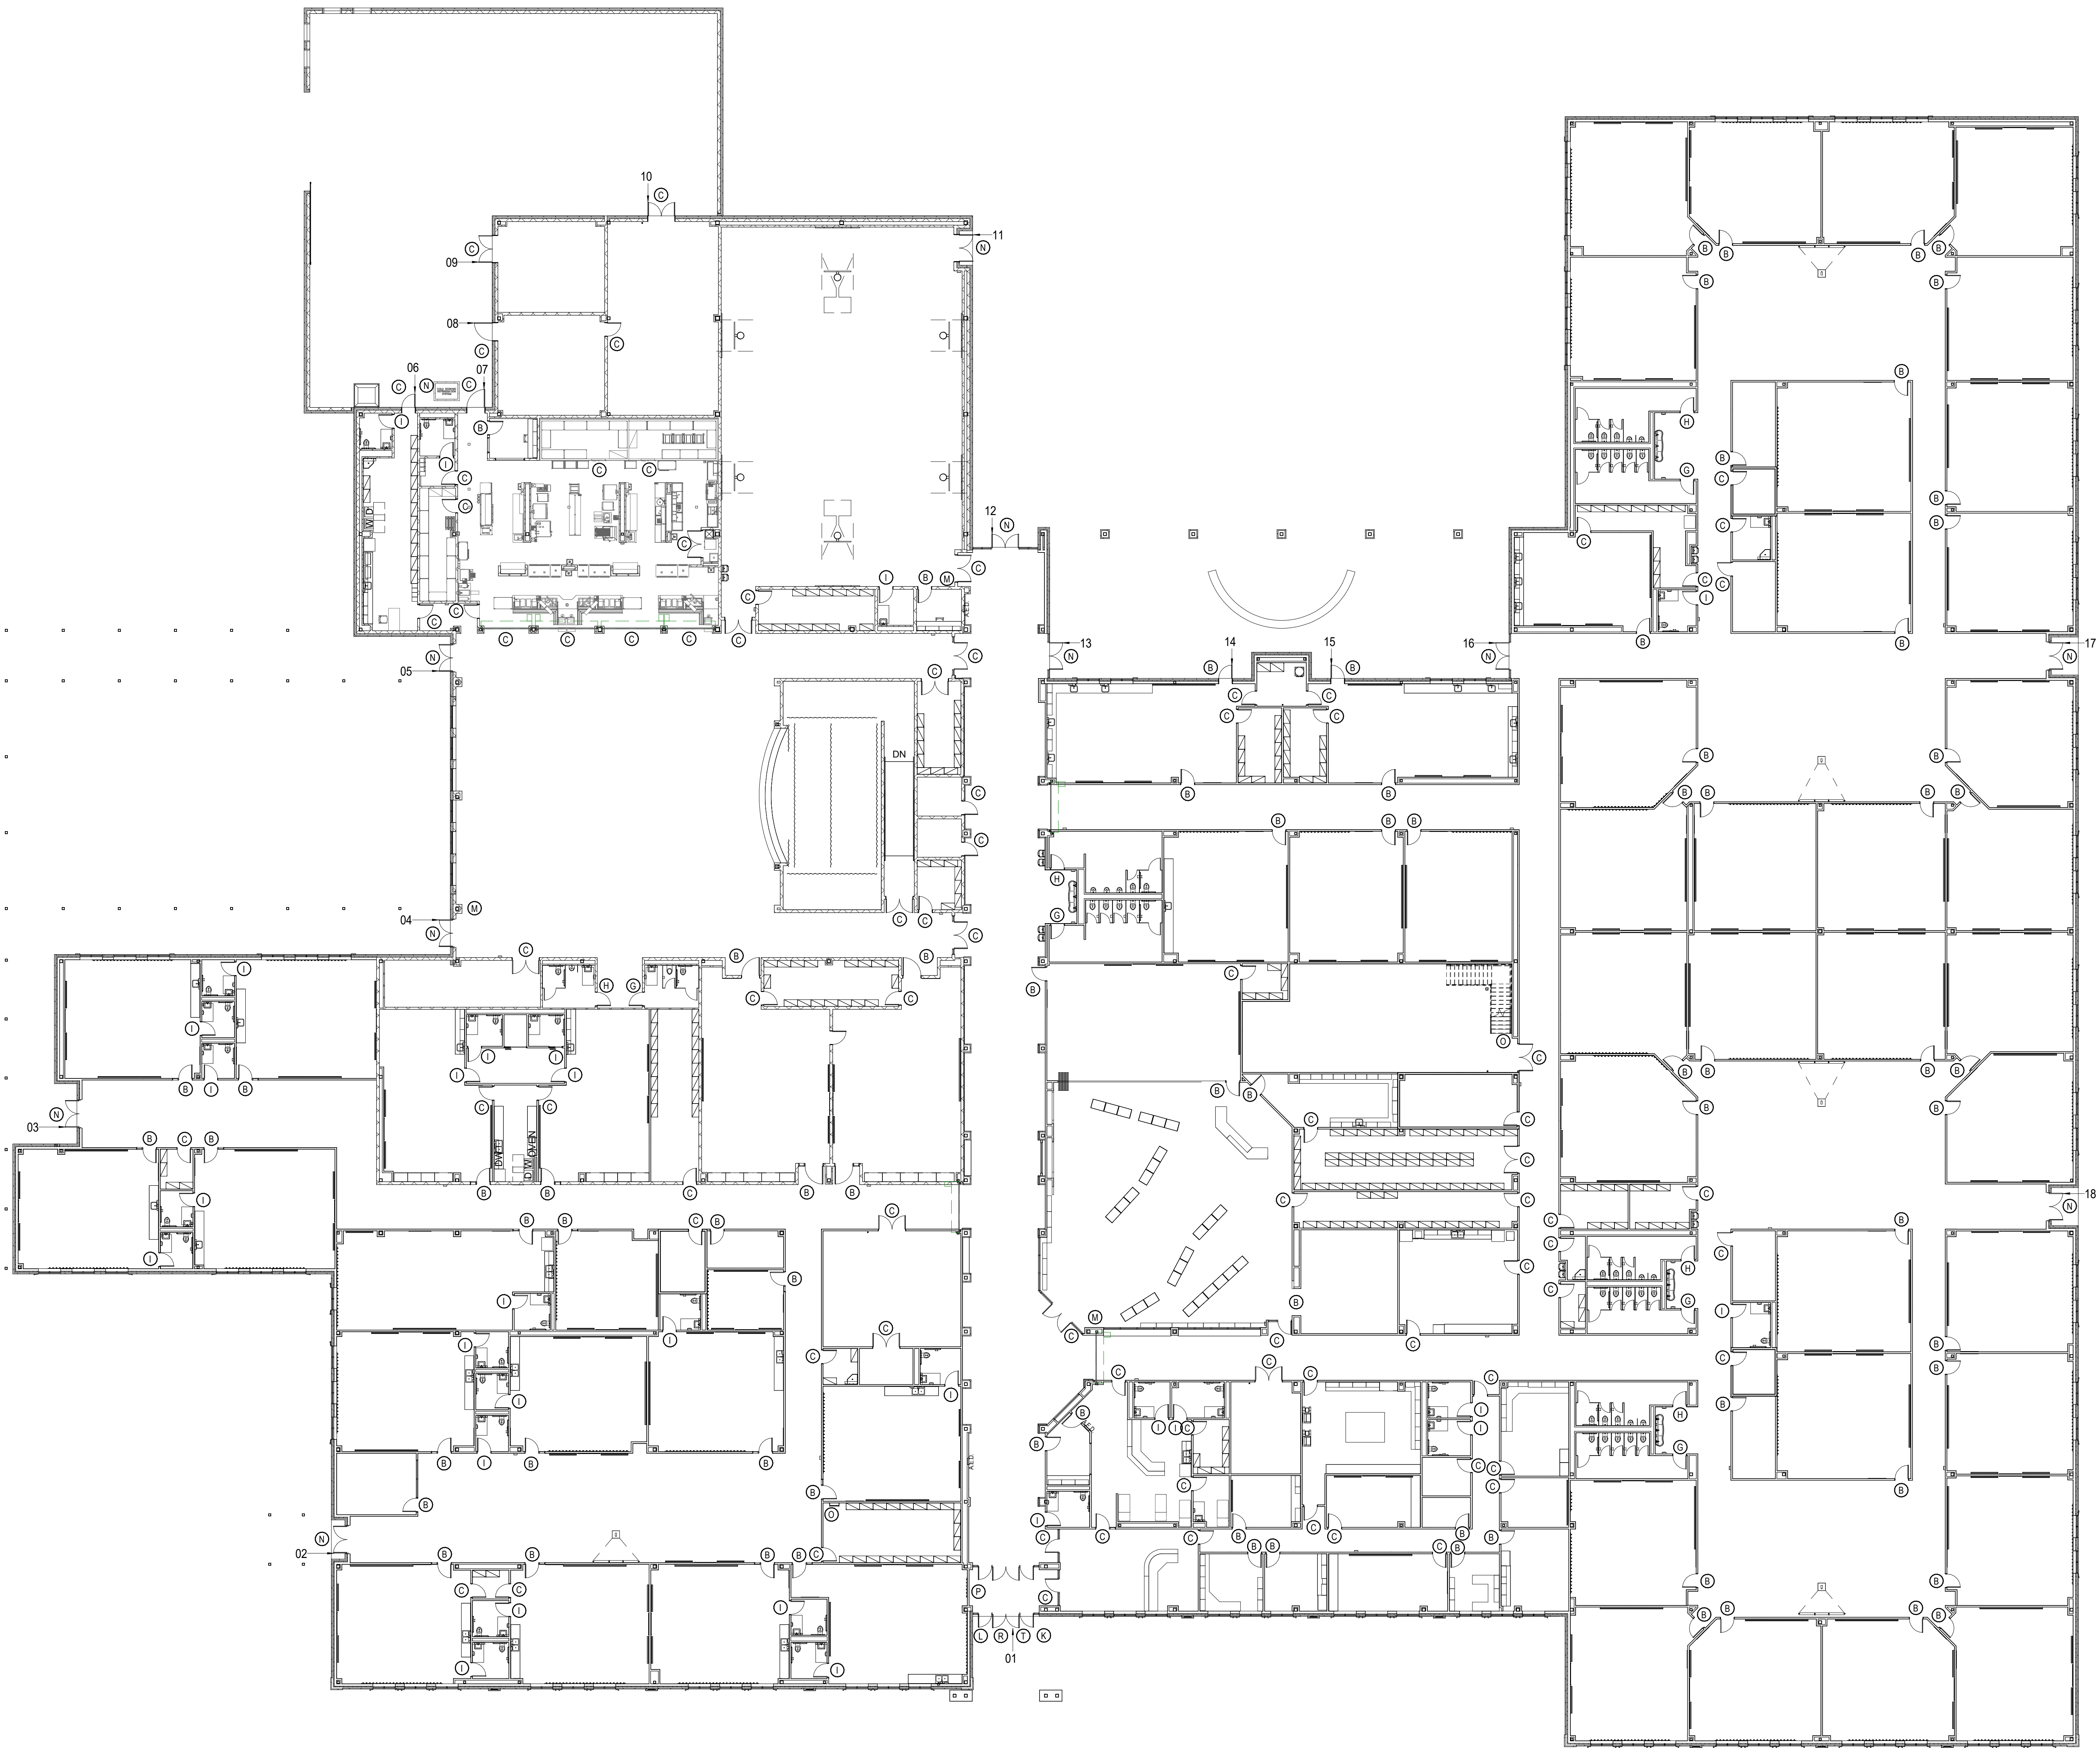


WATER CLOSET: To Top of Seat	12" - 15"
Grab Bar Height	20" - 25"
Flush Control Height	18" TYP. 40" MAX.
URINAL: Max. To Rim of Basin	14"
Flush Control Height (Max)	40"
LAVATORIES: Front Approach	40"
Knee Clearance (Min)	24"
To Top (Max)	31"
To Faucet (Max)	18"
FIXED OR BUILT-IN:	
Height of Tables or Counter:	26" - 30"
Knee Clearance (Min)	24"
SHELVES, DISPENSERS: Max: Height to Control Device	
Frontal Approach (Max)	40"
Side Approach (Max)	40"
DRINKING FOUNTAINS:	
To Spout (Max)	30"
Knee Clearance (Min)	24"
SWITCHES AND CONTROLS	
Frontal Approach (Max)	40"
Side Approach (Max)	40"
MIRRORS: Max: Height to Bottom of Reflective Surface	
At Lavatories and Counter Tops	34"
Full Length	40"
MIRRORS: Min. Height to Top of Reflective Surface	
Full Length	74"
TOILET PAPER DISPENSER: Height to Center of Roll	14" - 17"
PAPER TOWEL DISPENSER: Height to Operating Mechanism	40"
SHOWER	
Top of Seat	12" - 15"
Grab Bar	20" - 25"
To Hand Shower Head Mounting (Max)	40"
MARKER BOARDS / TACKBOARDS	COORD. MOUNTING HEIGHT WITH OWNER PRIOR TO INSTALL



TOTAL	226
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RE: G-051 & G-052 FOR PLAQUE TYPES



1. PER TEXAS EDUCATION AGENCY STANDARDS; NUMBER ALL EXTERIOR DOORS (INTERIOR AND EXTERIOR) WITH A 6" BLACK VINYL NUMBER WITH THE MAIN ENTRANCE BEING NUMBER ONE AND THE REMAINING DOORS BEING NUMBERED IN A CLOCKWISE ORDER AS SHOWN IN PLAN.




ARCHITECT	PBK Architects, Inc. HOUSTON 11 Greenway Plaza, 22nd Floor Houston, TX 77046 713-965-0808 P 713-961-4571 F TX Firm BR 1688
OWNER	HOUSTON 11 Greenway Plaza, 22nd Floor Houston, TX 77046 713-965-0808 P 713-961-4571 F TX Firm BR 1688
DESIGNER	HOUSTON 11 Greenway Plaza, 22nd Floor Houston, TX 77046 713-965-0808 P 713-961-4571 F TX Firm BR 1688
LANDSCAPE	HOUSTON 11 Greenway Plaza, 22nd Floor Houston, TX 77046 713-965-0808 P 713-961-4571 F TX Firm BR 1688
STRUCTURAL	HOUSTON 11 Greenway Plaza, 22nd Floor Houston, TX 77046 713-965-0808 P 713-961-4571 F TX Firm BR 1688
MECHANICAL	HOUSTON 11 Greenway Plaza, 22nd Floor Houston, TX 77046 713-965-0808 P 713-961-4571 F TX Firm BR 1688
ELECTRICAL	HOUSTON 11 Greenway Plaza, 22nd Floor Houston, TX 77046 713-965-0808 P 713-961-4571 F TX Firm BR 1688
PLUMBING	HOUSTON 11 Greenway Plaza, 22nd Floor Houston, TX 77046 713-965-0808 P 713-961-4571 F TX Firm BR 1688
MECHANICAL	HOUSTON 11 Greenway Plaza, 22nd Floor Houston, TX 77046 713-965-0808 P 713-961-4571 F TX Firm BR 1688
MECHANICAL	HOUSTON 11 Greenway Plaza, 22nd Floor Houston, TX 77046 713-965-0808 P 713-961-4571 F TX Firm BR 1688

TOMBALL WEST ELEMENTARY SCHOOL

JUERGEN ROAD
TOMBALL, TX

ISSUE FOR PROPOSAL

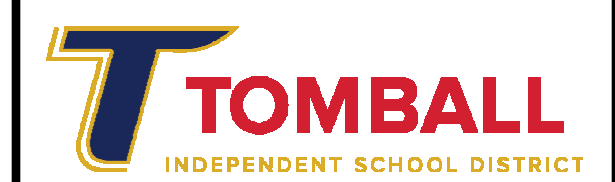

KEY PLAN

C
B
D

E
A

H
G
F

NORTH: PLAN TRUE




CLIENT TOMBALL ISD		
DATE 02/27/2023		PROJECT NUMBER 220137
DRAWING HISTORY		
No.	Description	Date

ISSUE FOR PROPOSAL

BUILDING NUMBER


2ND FLOOR
GRAPHICS &
SIGNAGE PLAN -
COMPOSITE

G-042

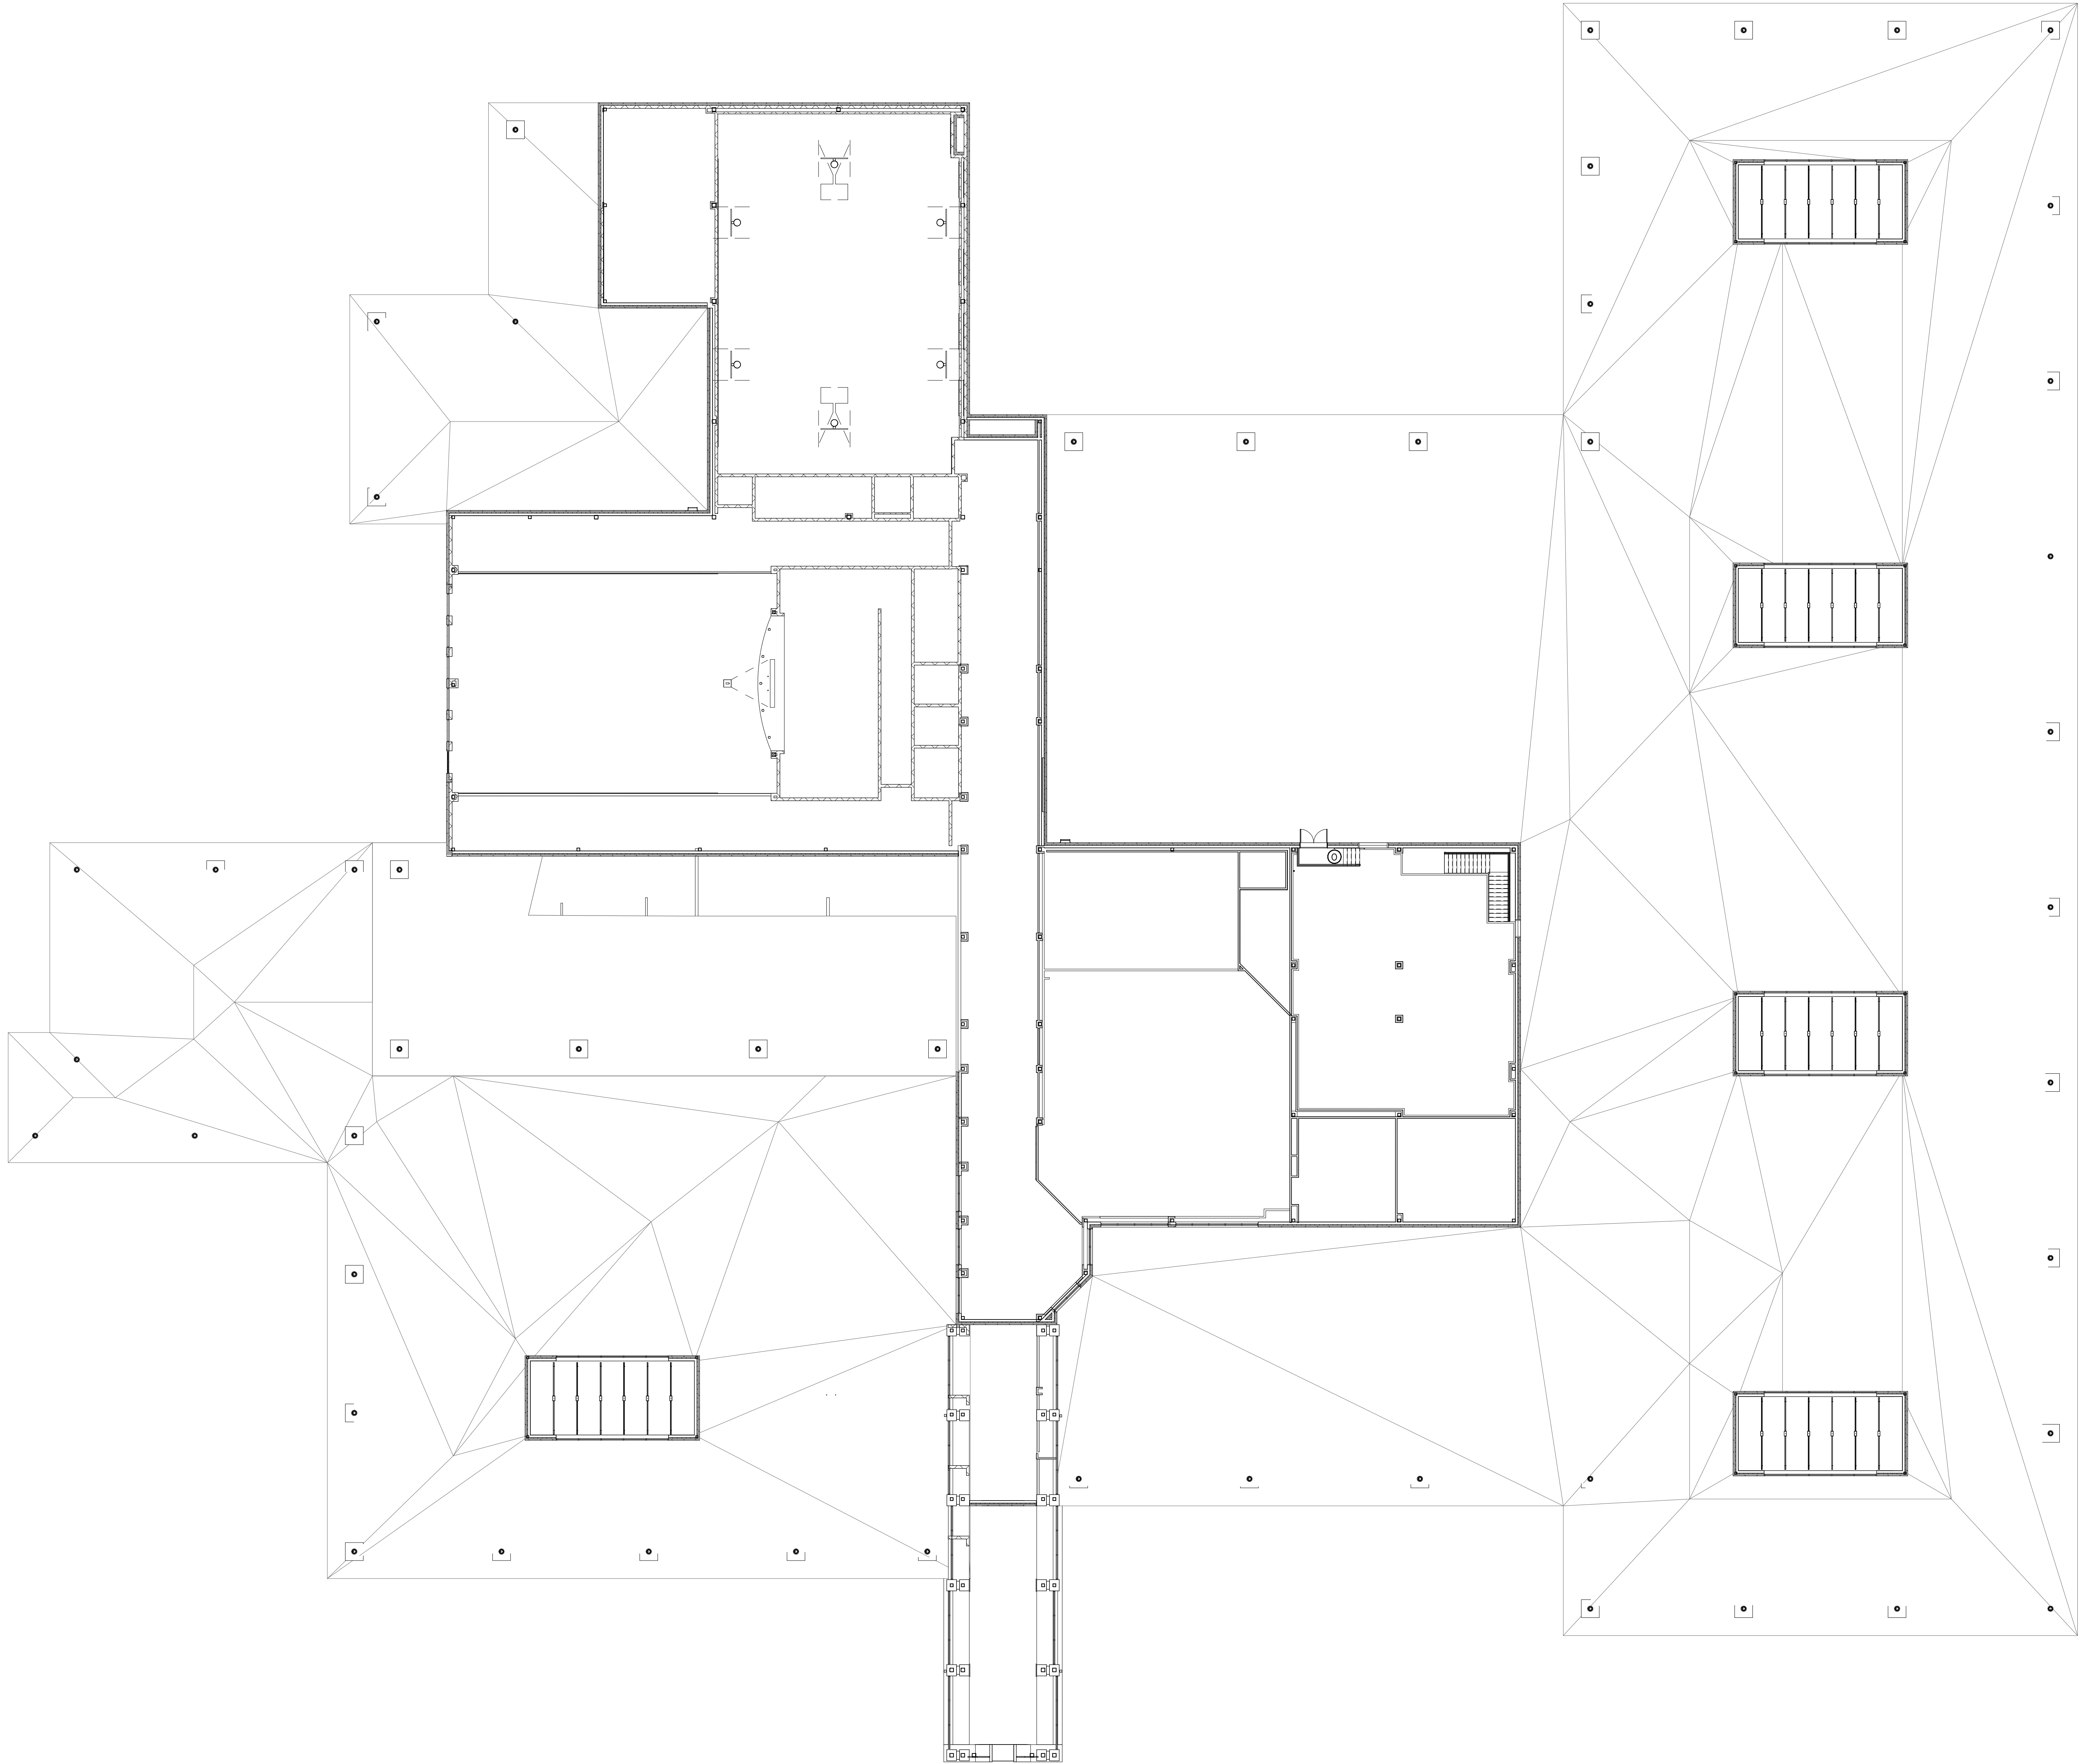

06 2ND FLOOR PLAN SIGNAGE PLAN
1/16" = 1'-0"

1. EXTERIOR ALUMINUM SIGNAGE, .125" THICK. CONFIRM ACTUAL LOCATION WITH ARCHITECT PRIOR TO INSTALLATION.

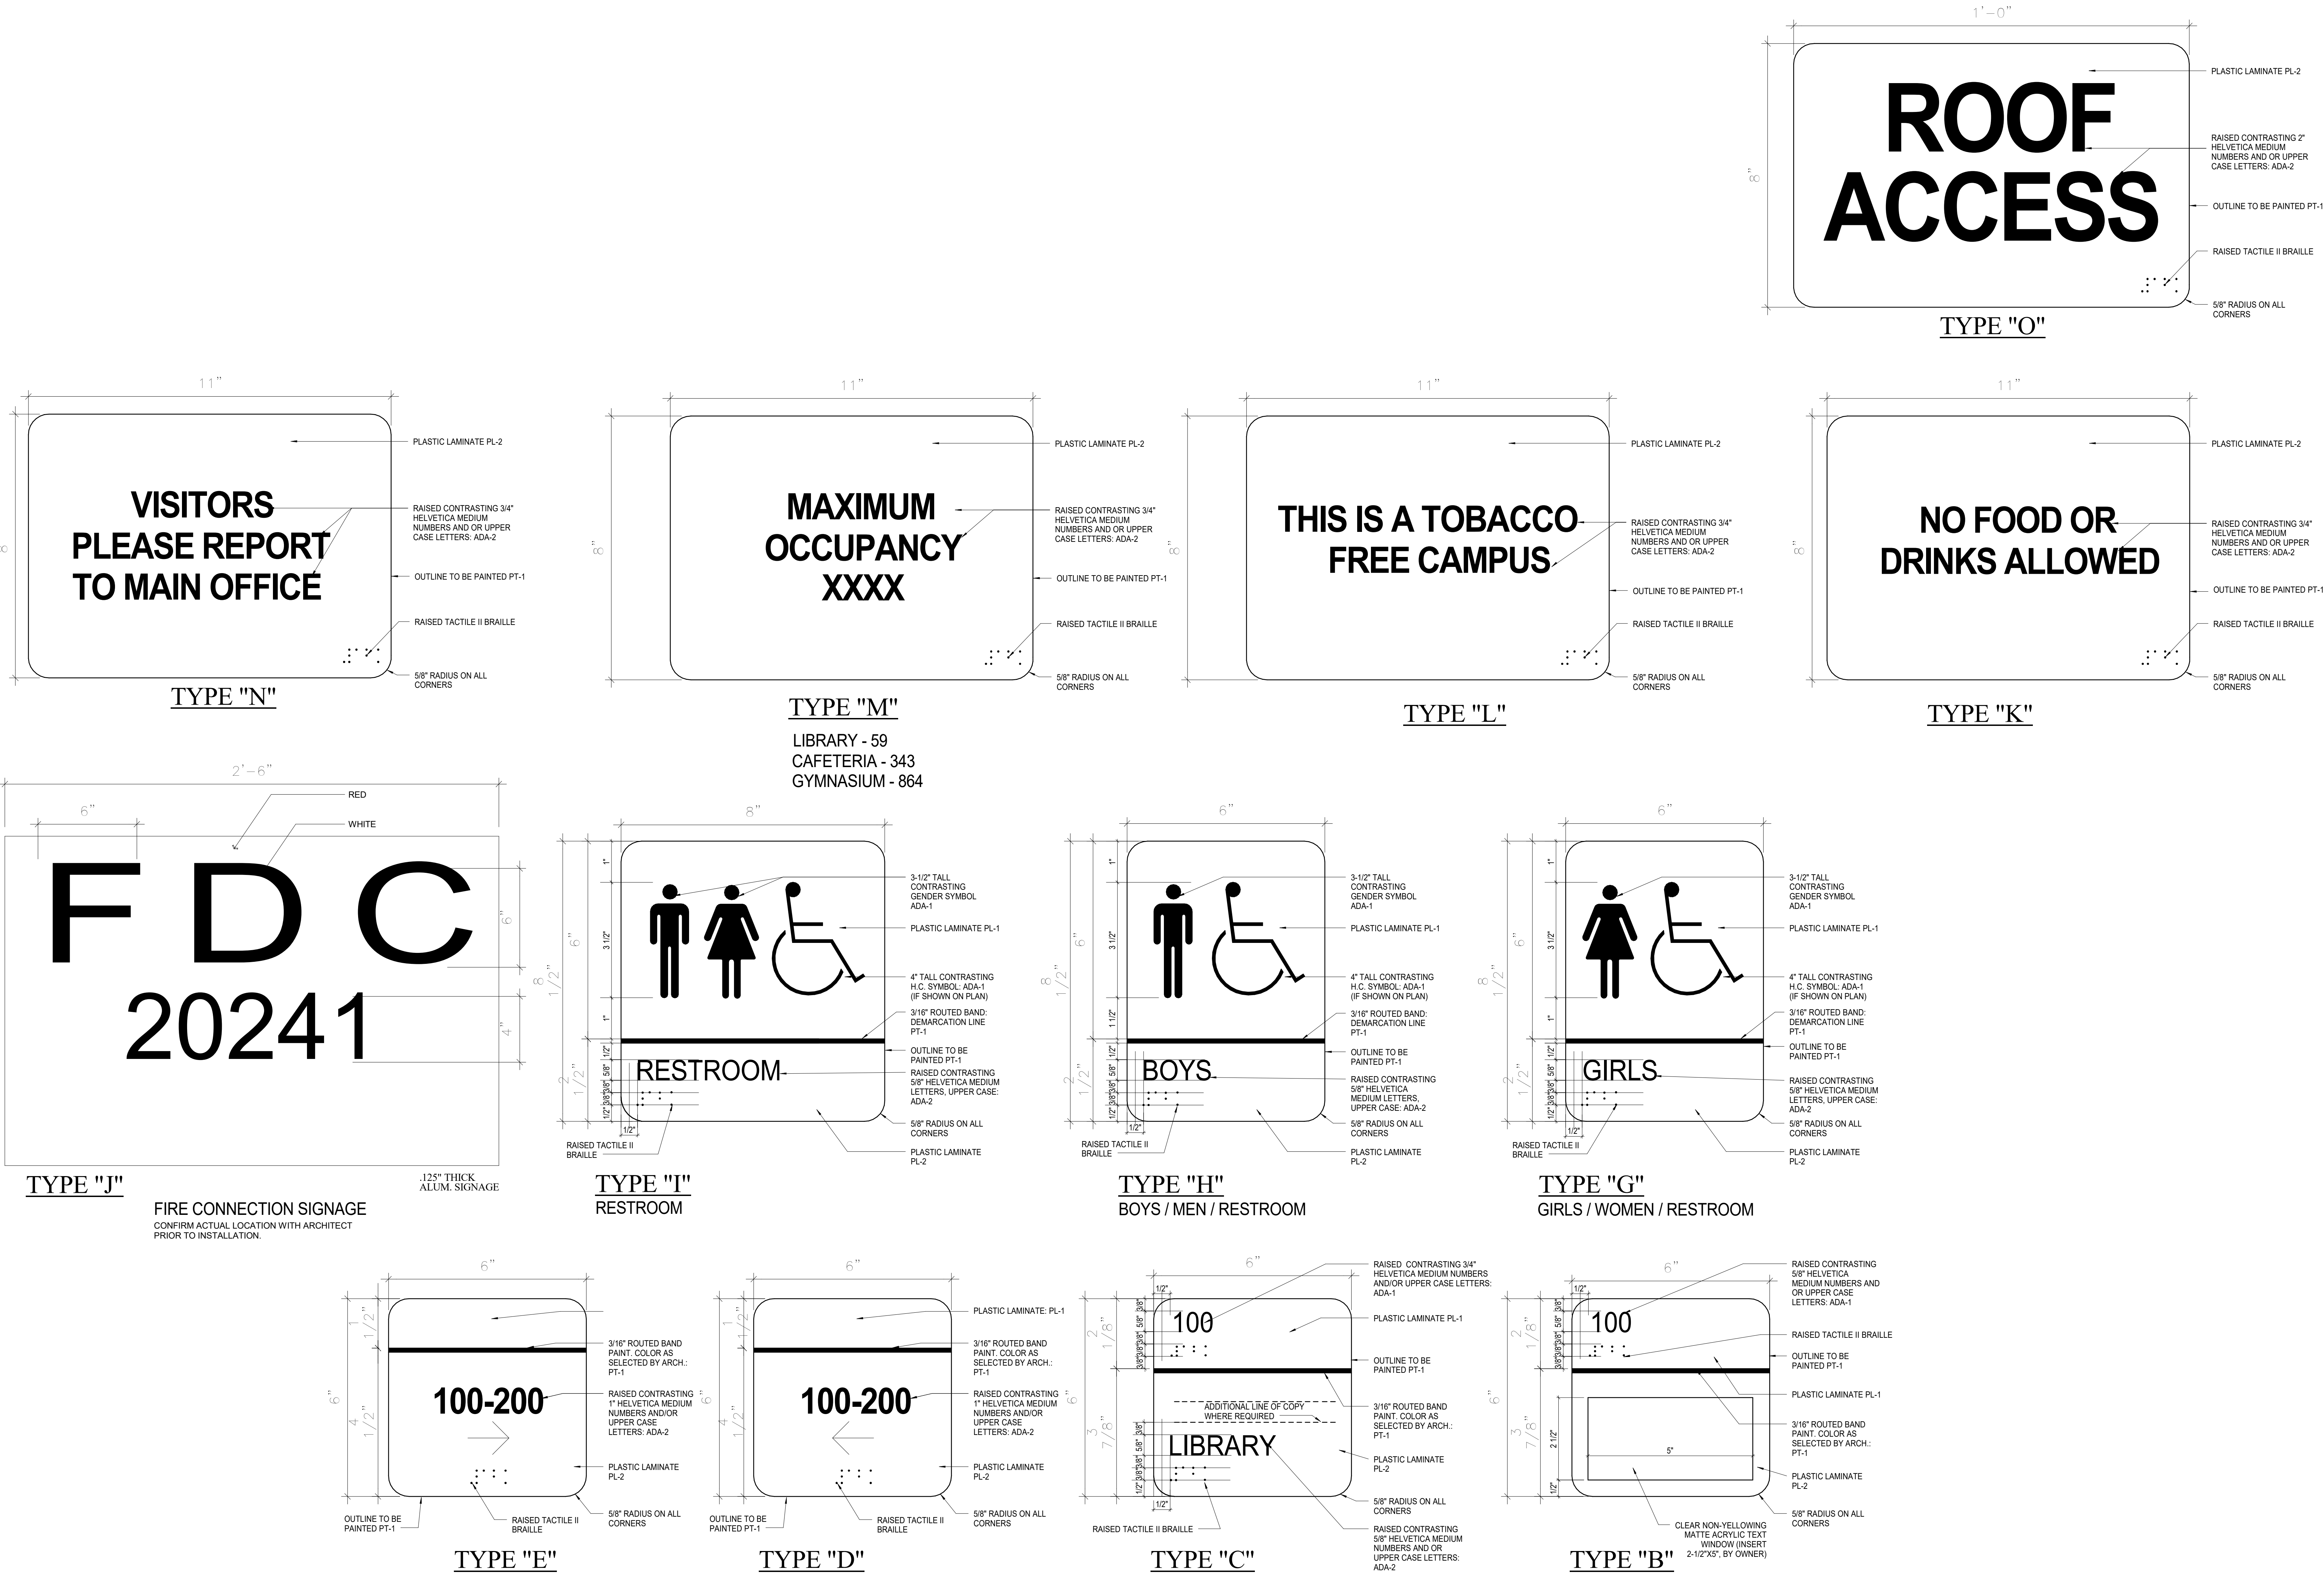

ARCHITECT

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PBK.com

DESIGNER

1713460.3258

LANDSCAPE

1713460.3258

GREENSCAPE

1713460.3258

STRUCTURAL

1713460.3258

MATERIALS

1713460.3258

MECHANICAL

1713460.3258

PLUMBING

1713460.3258

ELECTRICAL

1713460.3258

FOOD SERVICE

1713460.3258

FOODSERVICE DESIGN PROFESSIONALS

1713460.3258

TOMBALL WEST ELEMENTARY SCHOOL

JUERGEN ROAD
TOMBALL, TX

ISSUE FOR PROPOSAL

TOMBALL

INDEPENDENT SCHOOL DISTRICT

KEY PLAN

NORTH: PLAN TRUE

REGISTERED ARCHITECT

GREGORY A. PINKER

27199

02/27/2023

CLIENT

TOMBALL ISD

DATE

02/27/2023

PROJECT NUMBER

220137

DRAWING HISTORY

No.	Description	Date

ISSUE FOR PROPOSAL

BUILDING NUMBER

SIGNAGE GRAPHIC STANDARDS

G-051

